



Baffle/Weir Detail




Completed Settling Pond System

DO NOT SCALE FROM THIS DRAWING. USE FIGURED DIMENSIONS IN ALL CASES. VERIFY DIMENSIONS ON SITE AND REPORT ANY DISCREPANCIES TO THE DESIGNERS IMMEDIATELY.  
THIS DRAWING IS TO BE READ IN CONJUNCTION WITH THE DESIGNERS SPECIFICATION.  
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- NOTES:
1. ALL DRAWINGS ARE TO BE READ IN CONJUNCTION WITH ALL RELEVANT SPECIFICATIONS, BILLS OF QUANTITIES, ARCHITECTURAL, SERVICES AND ENGINEERING DRAWINGS.
  2. ALL LEVELS ARE IN METRES RELATED TO ORDNANCE DATUM MALIN HEAD.
  3. ANY DISCREPANCIES BETWEEN THESE DOCUMENTS SHALL BE BROUGHT TO THE ATTENTION OF THE ENGINEER.
  4. DRAWINGS ARE NOT TO BE SCALED.
  5. ALL DIMENSIONS ARE IN MILLIMETRES, UNLESS NOTED OTHERWISE.
  6. THE FINALISED LAYOUT MAY BE SUBJECT TO MICRO-SITING DUE TO UNFORESEEN GROUND CONDITIONS. THE EXTENT OF FLEXIBILITY WILL BE SITE SPECIFIC AND SHOULD GENERALLY NOT EXCEED BEYOND 20 METRES.


REFERENCE DRAWINGS:

DRAWING No.	Description
19715-MWP-00-00-DR-C-5005	Proposed Site Layout - Master Sheet
19715-MWP-00-00-DR-C-5016	Proposed Site Drainage Layout - Master Sheet

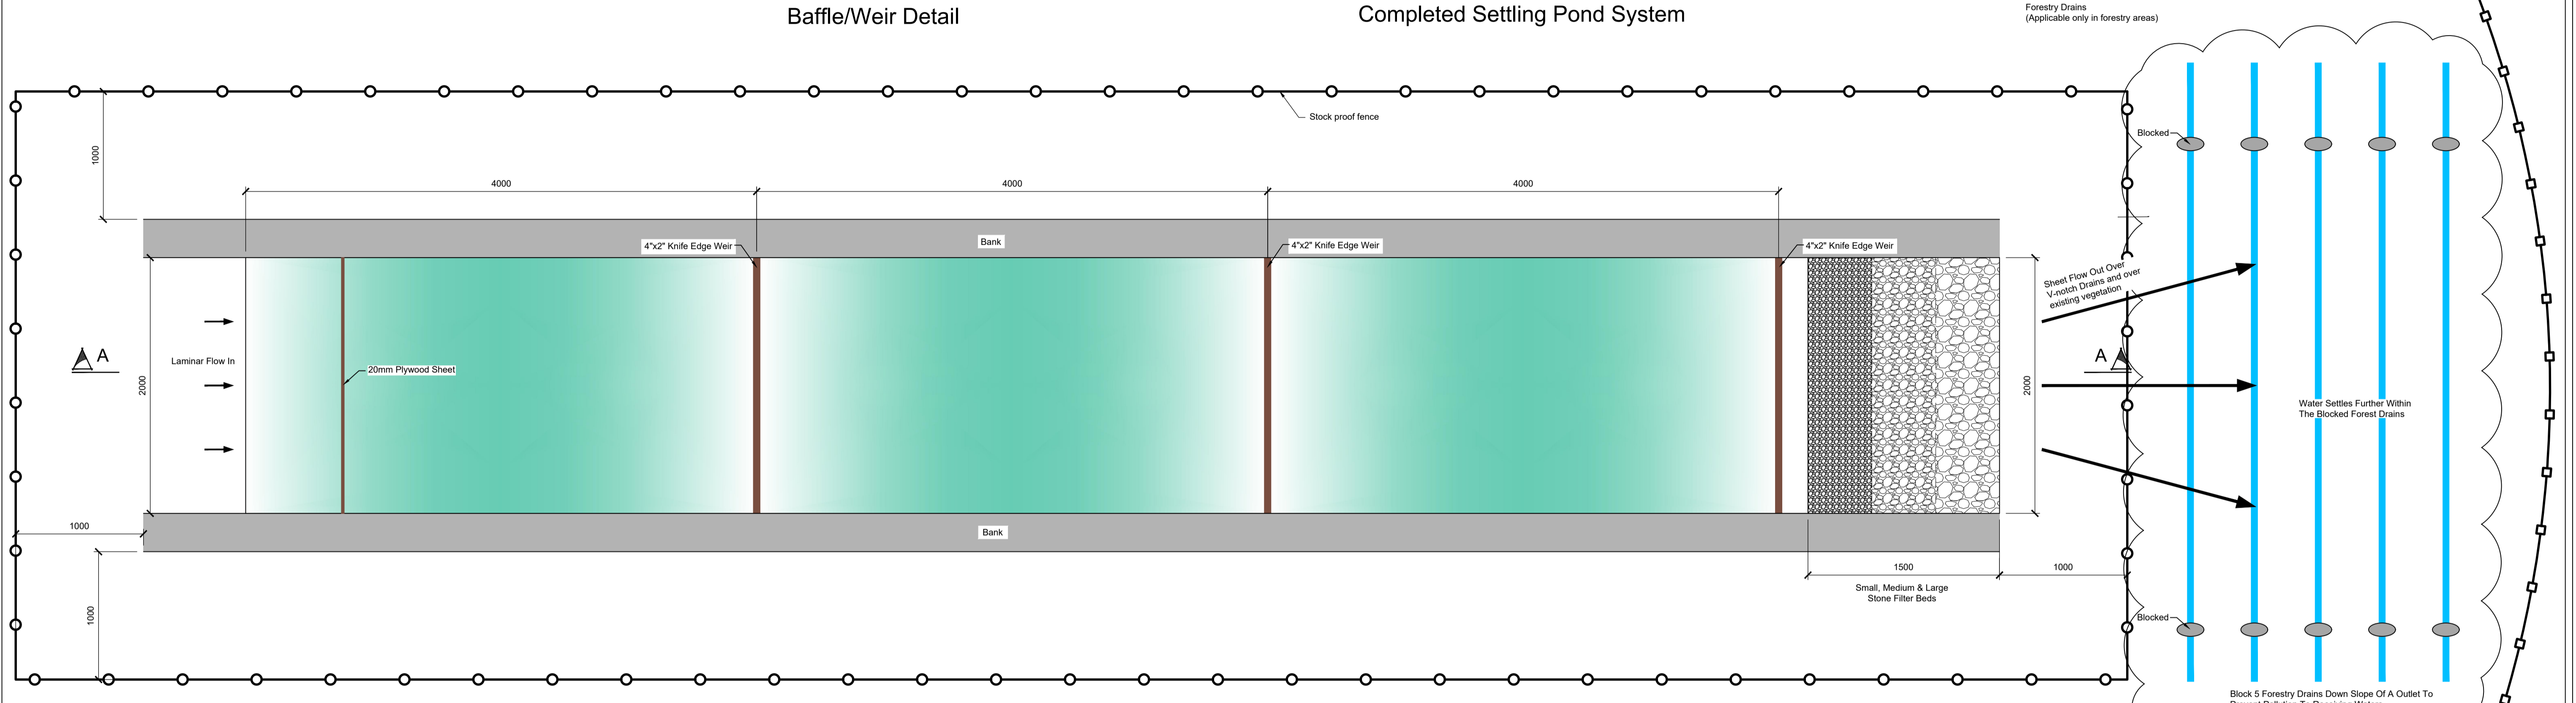

Plan View Of Silt Ponds (with Discharge To Drains Where Applicable) Scale 1:25

All Sizings Are Typical And Are Subject To Detailed Design

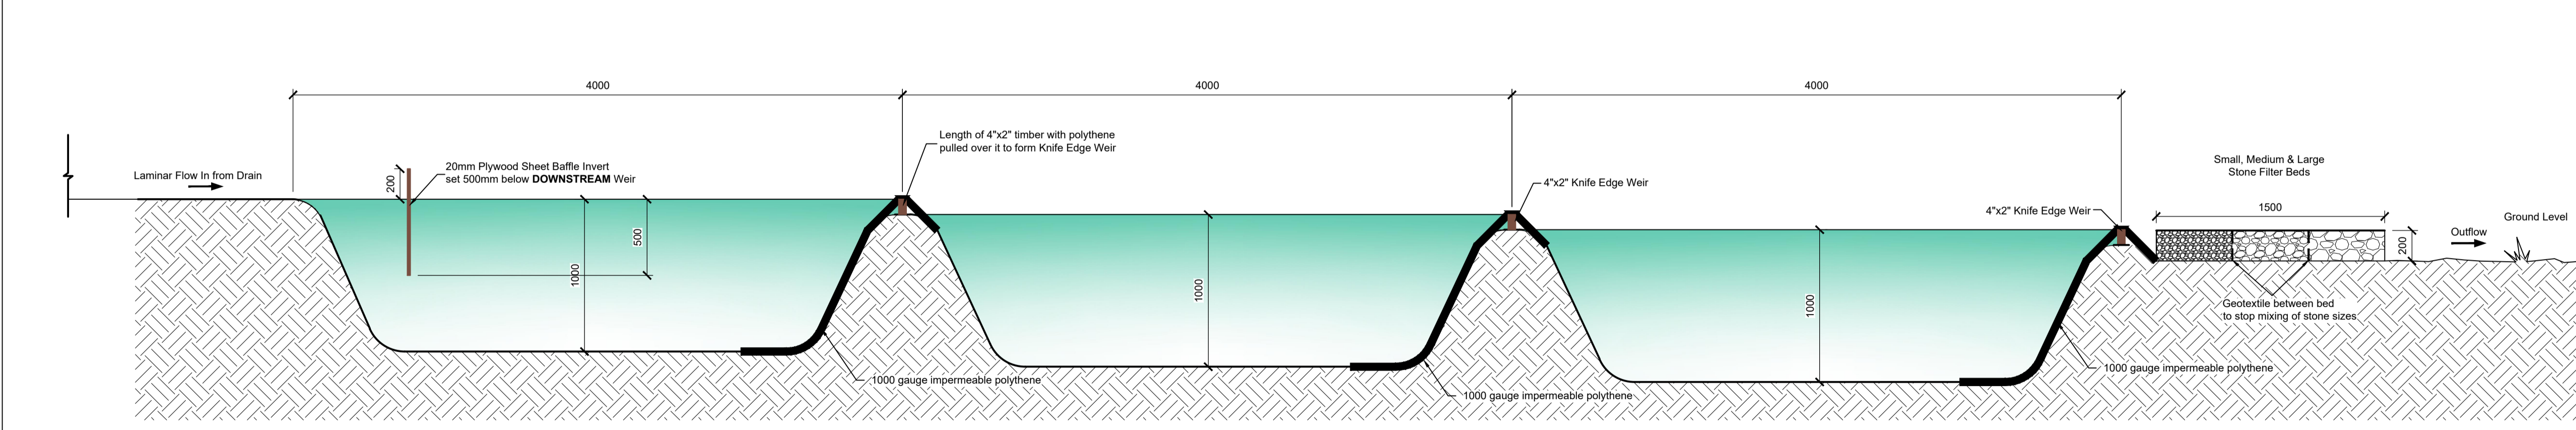

Section A-A Scale 1:25

All Sizings Are Typical And Are Subject To Detailed Design

HY-TEX Terrastop Premium Silt Fence or similar approved. Held in place with 75mm Sq by 1.0m height timber posts @ 1.5m c/c

REV	DATE	ISSUED FOR PLANNING	DESCRIPTION	JK	ED
P01	11/02/2020				

PROJECT: Drumnahough Wind Farm

TITLE: Drainage Details - Sheet 1

CLIENT: Drumnahough Wind Farm DAC

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DRAWN: JK	CHECKED: PC	APPROVED: PC
DATE: May 2020	SCALE @ A1: As Shown	
PROJECT NUMBER: 19715	DRAWING STATUS: S2	

DRAWING NUMBER: 19715-MWP-00-00-DR-C-5404	REV: P01
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